

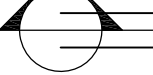





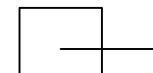


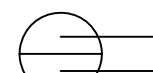


MR. ELLIOT TISHBI		Z Y A GROUP C.A. 90404 983 - 7176
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1111 LAS LOMAS AVE. PACIFIC PALISADES CA 90272

ABBREVIATIONS & SYMBOLS

ACOUS.	ACOUSTICAL	H.B.	HOSE BIBB	TER.	TERRAZZO
A.D.	AREA DRAIN	H.C.	HOLLOW CORE	T & G	TONGUE & GROOVE
ADJ.	ADJUSTIBLE	HDWD.	HARD WOOD	THK.	THICK
ACGR.	AGGREGATE	HDWE.	HARDWARE	T.P.	TOP OF PAVEMENT
AL.	ALUMINUM	H.M.	HOLLOW METAL	T.L.	TELEVISION
ALT.	ALTERNATIVE	HORIZ.	HORIZONTAL	T.W.	TOP OF WALL
APPROX.	APPROXIMATE	HR.	HOOR	TYP.	TYPICAL
ARCH.	ARCHITECTURAL	HGT.	HEIGHT		
ASB.	ASBESTOS				
ASPH.	ASPHALT	I.D.	INSIDE DIAMETER(DIM.)	UNF.	UNFINISHED
@	AT	INSUL.	INSULATION	UR.	URINAL
&	AND	INT.	INTERIOR		
BD.	BOARD	JAN.	JANITOR	W	WEST
BIT.	BITUMEN	JT.	JOINT	W/	WITH
BLDG.	BUILDING			W.C.	WATER CLOSET
BLK.	BLOCK			WD.	WOOD
BLKG.	BLOCKING	KIT.	KITCHEN	W/O	WITHOUT
BM.	BENCH MARK			W.P.	WATERPROOF
BOT.	BOTTOM	LAB.	LABORATORY	WSCT.	WAINSCOT
		LAM.	LAMINATED	WT.	WEIGHT
		LAV.	LAVATORY		
		LKR.	LOCKER		
		LT.	LIGHT		
CAB.	CABINET				
CB.	CORNER BEAD				
CEM.	CEMENT				
CER.	CERAMIC	MAX.	MAXIMUM		
C.I.	CAST IRON	M.C.	MEDICINE CABINET		DETAIL NUMBER
CLG.	CEILING	MECH.	MECHANICAL		SHEET NUMBER
CLKG.	CAULKING	MEMB.	MEMBRANE		
CLOS.	CLOSURE	MTL.	METAL		SECTION LETTER
CLR.	CLEAR CLEARANCE	MFR.	MANUFACTURER		SHEET NUMBER
CL.	CENTER LINE	M.H.	MANHOLE		
COL.	COLUMN	MIN.	MINIMUM		ELEVATION NUMBER
CONC.	CONCRETE	MIR.	MIRROR		SHEET NUMBER
CONN.	CONNECTION	MISC.	MISCELLANEOUS		
CONST.	CONSTRUCTION	MTD.	MOUNTED		
CONT.	CONTINUOUS	MUL.	MULLION		
CORR.	CORRIDOR				
CTSK.	COUNTER SUNK	N	NORTH		WINDOW NUMBER
COUNT.	COUNTER	N.I.C.	NOT IN CONTRACT		
CTR.	CENTER	NO.	NUMBER		
C.T.	CERAMIC TILE	NOM.	NOMINAL		DOOR NUMBER
		N.T.S.	NOT TO SCALE		
DBL.	DOUBLE				
DEPT.	DEPARTMENT	O.A.	OVERALL		REFERENCE NUMBER
D.F.	DRINKING FOUNTAIN	O.C.	ON CENTER		
DET.	DETAIL	O.D.	OUTSIDE DIAMETER(DIM.)		
DIA.	DIAMETER	OFF.	OFFICE		
DIM.	DIMENSION	OPNG.	OPENING		
DISP.	DISPENSER	OPP.	OPPOSITE		SHEAR WALL NUMBER
D.O.	DOWN				
D.N.	DOOR OPENING	P.C.	PRE-CAST		DETAIL NUMBER
DR.	DOOR	PL.	PLATE		SHEET NUMBER
DWR.	DRAWER	PLAM.	PLASTIC LAMINATE		
D.S.	DOWNSPOUT	PLAS.	PLASTER		
D.S.P.	DRY STANDPIPE	PLYWD.	PLYWOOD		
DWG.	DRAWING	PR.	PAIR		
		PT.	POINT		
E	EAST	P.T.D.	PAPER TOWEL DISPENSER		
EA.	EACH	P.T.D./R.	COMBINATION PAPER TOWEL DISPENSER & RECEPTICLE		
E.J.	EXPANSION JOINT				
EL.	ELEVATION	PTN.	PARTITION		
ELEC.	ELECTRICAL	P.T.R.	PAPER RECEPTICLE		
ELEV.	ELEVATOR				
EMER.	EMERGENCY				
ENCL.	ENCLOSURE	Q.T.	QUARRY TILE		
E.P.	ELECTRICAL PANELBOARD				
EQ.	EQUAL				
EQPT.	EQUIPMENT	R.	RISER		
E.W.C.	ELECTRIC WATER COOLER	RAD.	RADIUS		
EXIST.	EXISTING	R.D.	ROOF DRAIN		
EXPO.	EXPOSED	REF.	REFERENCE		
EXP.	EXPANSION	REFR.	REFRIGERATOR		
EXT.	EXTERIOR	RGR.	REINFORCED		
		REQ.	REQUIRED		
		RM.	ROOM		
F.A.	FIRE ALARM	R.O.	ROUGH OPENING		
F.B.	FLAT BAR				
F.D.	FLOOR DRAIN				
FOUND.	FOUNDATION	S	SOUTH		
F.E.	FIRE EXTINGUISHER	S.C.	SOLID CORE		
F.E.C.	FIRE EXTINGUISHER CAP	S.C.D.	SEAT COVER DISPENSER		
F.H.C.	FIRE HOSE CABINET	SCHED.	SCHEDULE		
FIN.	FINISH	S.D.	SOAP DISPENSER		
FL.	FLOOR	SECT.	SECTION		
		SH.	SHELF		
		SHWR.	SHOWER		
FLASH.	FLASHING	SHT.	SHEET		
FLUOR.	FLUORESCENT	SIM.	SIMILAR		
F.O.C.	FACE OF CONCRETE	S.N.D.	SANITARY NAPKIN DISP.		
F.O.F.	FACE OF FINISH	S.N.R.			
F.O.S.	FACE OF STUDS	SPEC.	SPECIFICATION		
FFRF.	FIREPROOF	SQ.	SQUARE		
F.S.	FULL SIZE	S.ST.	STAINLESS STEEL		
FT.	FOOT OR FEET	S.S.	SERVICE SINK		
FTG.	FOOTING	STA.	STATION		
FURR.	FURRING	STD.	STANDARD		
FUT.	FUTURE	STL.	STEEL		
		STOR.	STORAGE		
GA.	GAUGE	STR.L.	STRUCTURAL		
GALV.	GALVANIZED	SUSP.	SUSPENDED		
G.B.	GRAB BAR	SYM.	SYMETRICAL		
GL.	GLASS				
GND.	GROUND	TRD.	TREAD		
GR.	GRADE	T.B.	TOWEL BAR		
GYP.	GYP SUM	T.O.C.	TOP OF CURB		
		TEL.	TELEPHONE		

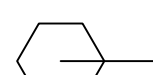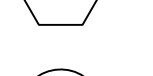SHEET INDEX

SHT. NO.	ARCHITECTURAL
A0.1	COVER SHEET AND PROJECT DATA
A0.1.1	SITE PLAN
A0.2	EXISTING FLOOR PLAN
A0.3	DEMOLITION PLAN
A1.0	FIRST FLOOR PLAN
A2.0	NEW BASEMENT PLAN & ROOF PLAN
A3.1	SECTIONS
A3.2	ELEVATIONS
G1.0	GREEN BUILDING CODE & NOTES

BUILDING SUMMARY

R11 Zone Maximum Residential Floor Area Calculation

Slope (%)	Area (Square Feet)	Ratio	Residential Floor Area
0% - 14.99%	8,488	0.40	3395.2 sq. ft.
15% - 29.99%	486	0.35	170.1 sq. ft.
30% - 44.99%	0	0.30	0 sq. ft.
45% - 59.99%	21	0.25	5.25 sq. ft.
60% - 99.99%	53	0.20	10.6 sq. ft.
100% +	47	0	0 sq. ft.

Maximum Residential Floor Area: 3581.15 sq. ft.

Bird's eye view maps can't be printed, so another map view has been substituted.

Showing Setbacks
From the Front Property Line
of all Buildings on the same
side of the street to the front yard Buildings

12'-8" set Back all Building
near to ours

Date: June 12, 2015

Site Address: 1111 Las Lomas Avenue, Pacific Palisades


Area: 9,095 square feet; 0.21 acres

Plan Prepared For: 1111 Las Lomas Avenue
Pacific Palisades, CA 90272

Plan Prepared By: Alfredo Sillas, L.S. 9113
1644 N Avon Street
Burbank CA, 91505
(818) 850-0584

(N) RFA	EXEMPT	TOTAL
1,170 S.F.	2,388 S.F.	3,558 S.F.
+ BASEMENT	INCLUDING GARAGE	+ BASEMENT

VICINITY MAP

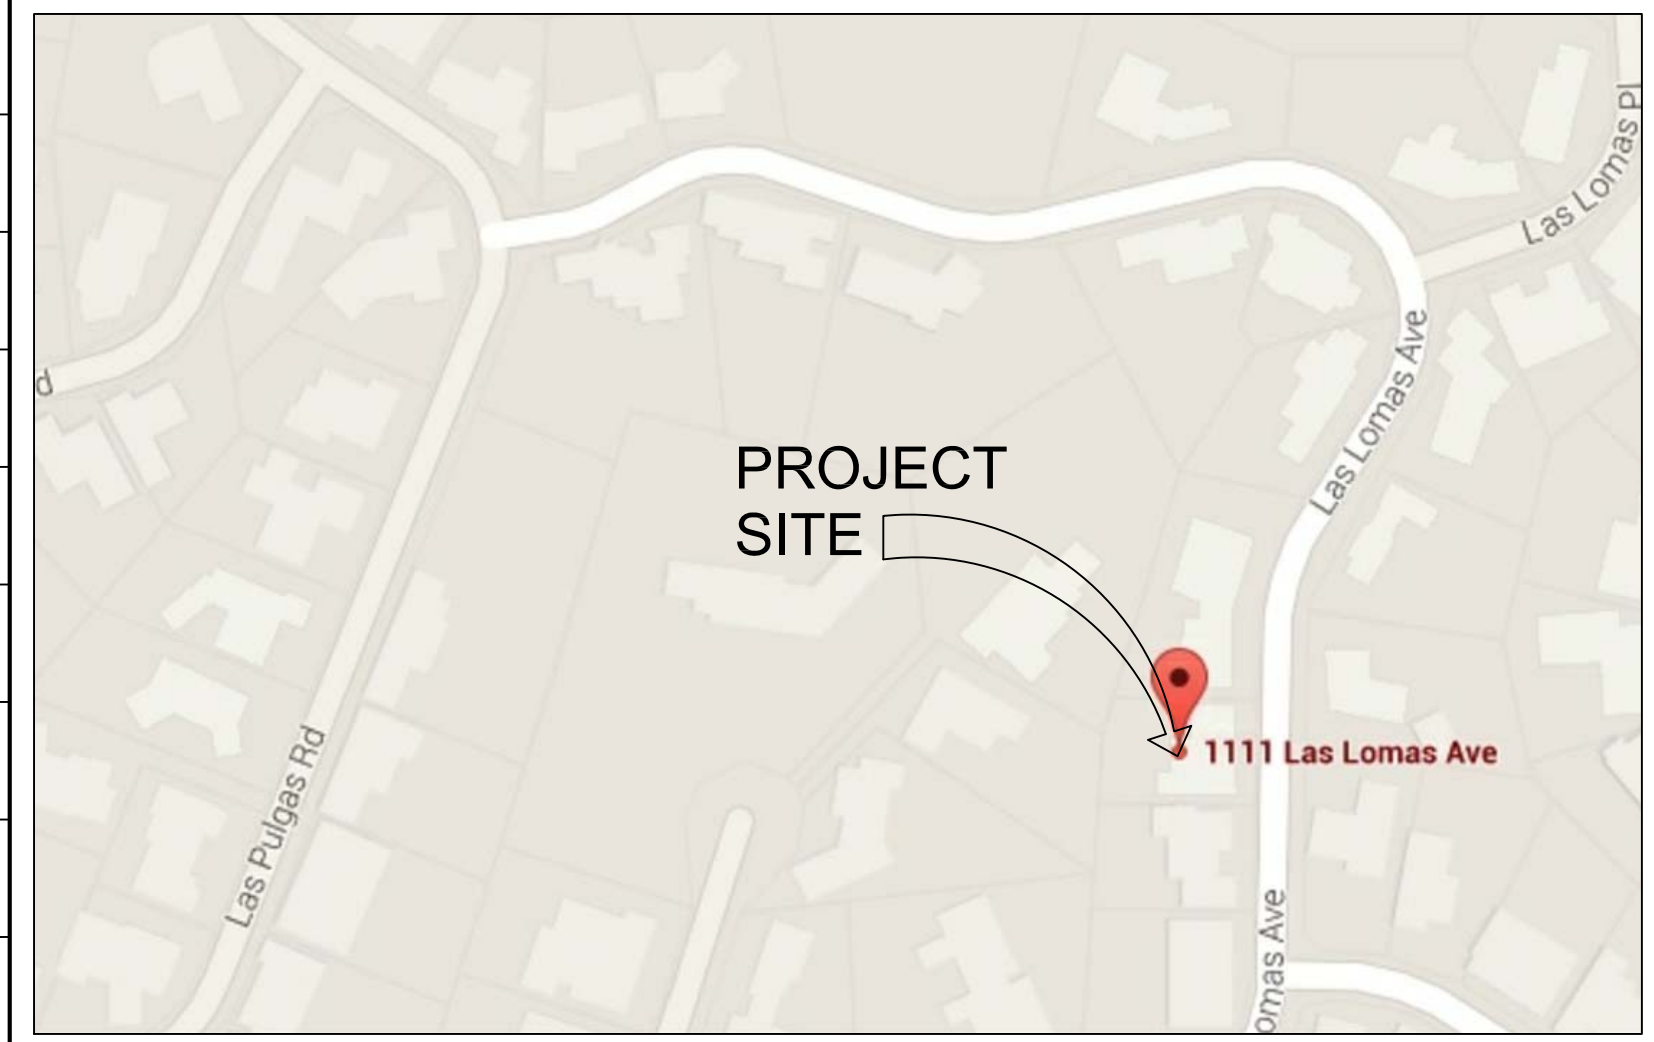

PROJECT DATA

PROJECT DESCRIPTION: ADDITION TO EXISTING BASEMENT
AND ADD DECK AND POOL

LEGAL DESCRIPTION: TRACT# TR 15948 / LOT 23

PROJECT ADDRESS: 1111 LAS LOMAS AVE. PACIFIC
PALISADES CA 90272
LOT AREA: 9,095 S.F. 0.21 AC.

EASEMENT: NO/ EXISTING BUILDING 2,667 S.F.
NUMBER OF STORIES: 1 STORY & BASEMENT PARKING
TOTAL OF ALL ENCLOSED STRUCTURES ON PROPERTY: 3,575 S.F.

DEVELOPMENT AREA ADDITION: 908 SQ.FT.

COVERED PARKING SPACES: ENCLOSED: 2

ZONE: RE 11

DISTRICT: WEST LOS ANGELES

OCCUPANCY: 1

MUNICIPAL CODES: RESIDENTIAL

TYPE OF CONSTRUCTION: V

HEIGHT: 18'-0"

(N) BASEMENT: 690 S.F.

PROJECT TEAM

OWNER:
MR. ELLIOT TISHBI
1111 LAS LOMAS AVE. PACIFIC PALISADES CA 90272

DESIGNER:
BOB BADIYAN & ASSOCIATE DESIGN GROUP
1318 16TH ST. SANTA MONICA CA 90404
TEL: 310.980.1657 FAX: 310.393.7175

STRUCTURAL ENGINEER:

CURRENT CODES ARE 2014 LARC, LABC, GREEN BLDG.

BOB BADIYAN
AND ASSOCIATE, DESIGN GROUP

1318, 16TH ST., SANTA MONICA CA 90404

T 310 - 980 - 1667 F 310 - 393 - 7179

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A ADDITIONAL RESIDENCE FOR
MR. ELLIOT TISHBI
1111 LAS LOMAS AVENUE, PACIFIC PALISADES CA 90272

PROJECT NUMBER


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SHEET TITLE

COVER SHEET

SHEET NO.

A0.1

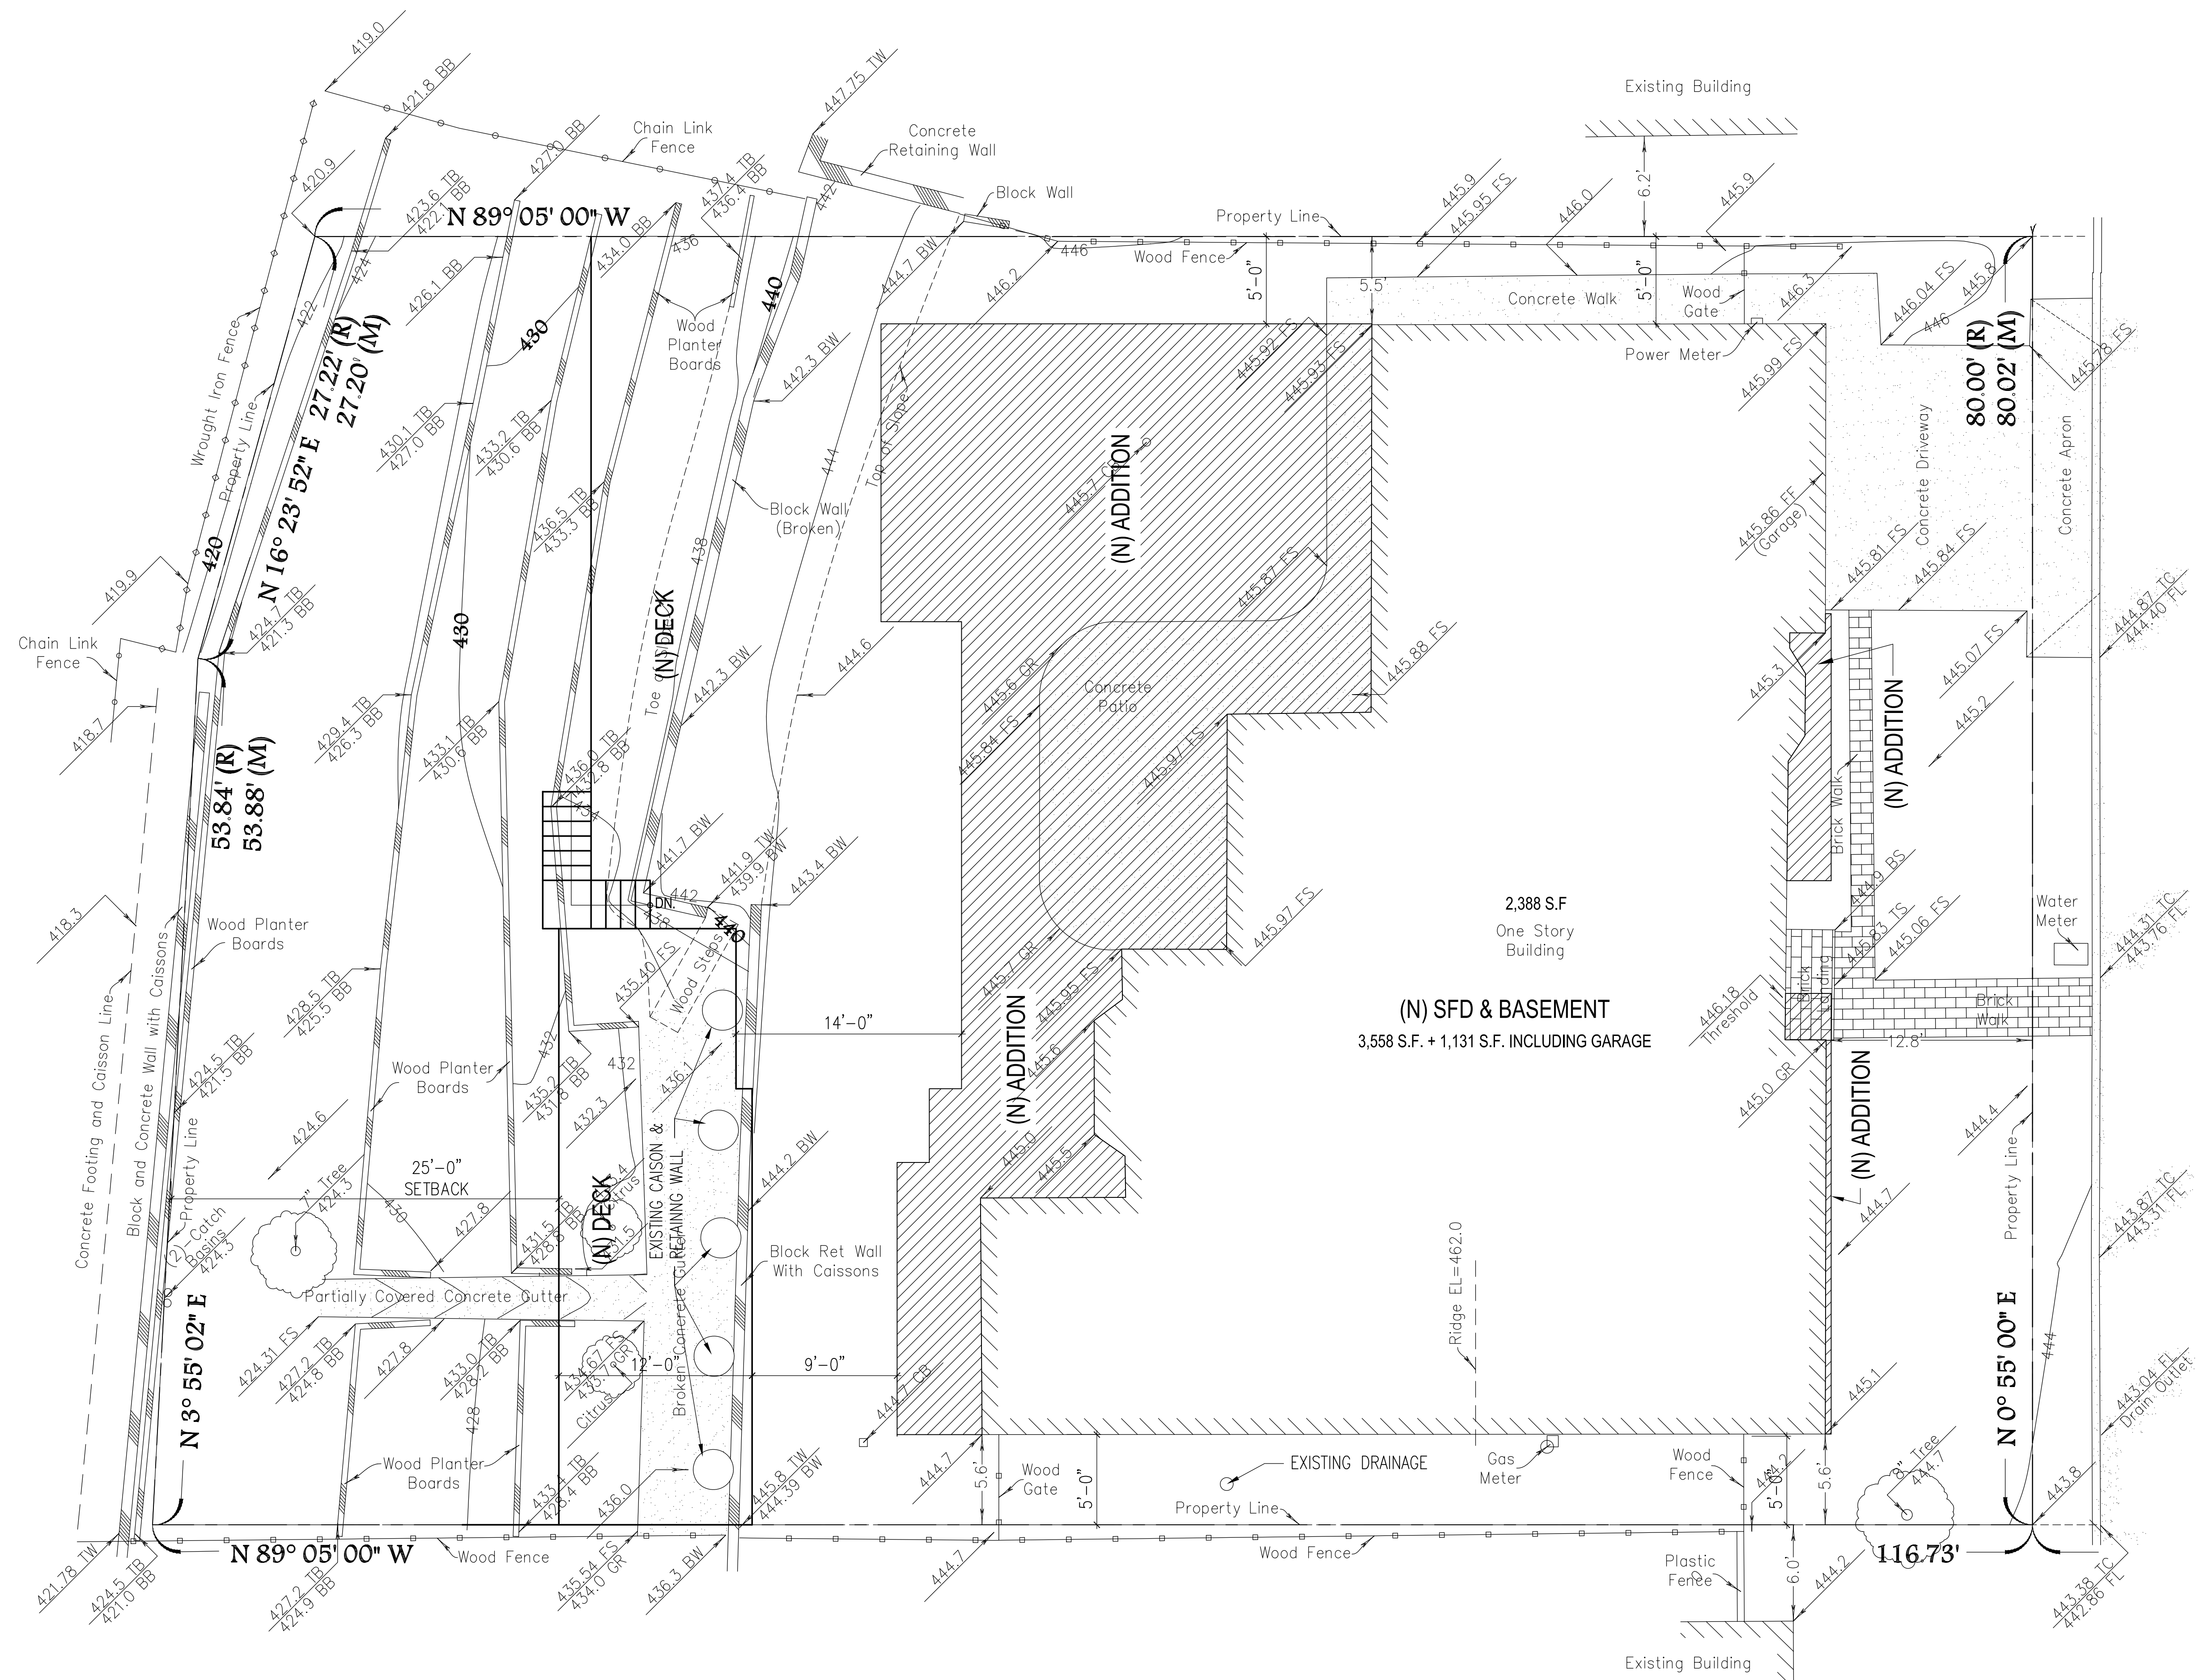

SITE PLAN

SCALE:
3/16" = 1'-0"

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SITE PLAN

SHEET NO.

A0.1.1

PROJECT NUMBER

JULY 16, 2015

REVISIONS

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SCALE:
3/16" = 1'-0"

===== INDICATES EXISTING WALLS TO REMAIN.

----- INDICATES EXISTING WALLS TO BE REMOVED.

SHEET TITLE

DEMOLITION
FLOOR PLAN

A0.3

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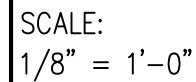
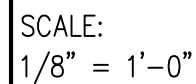
DEMOLITION FLOOR PLAN

A0.3

1111 LAS LOMAS AVENUE. PACIFIC PALISADES CA 90272

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1318 16TH ST. SANTA MONICA CA 90404



SHEET NO,
A2.0



SCALE:
1/8" = 1'-0"

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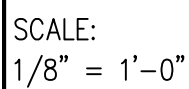
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1/8" = 1'-0"

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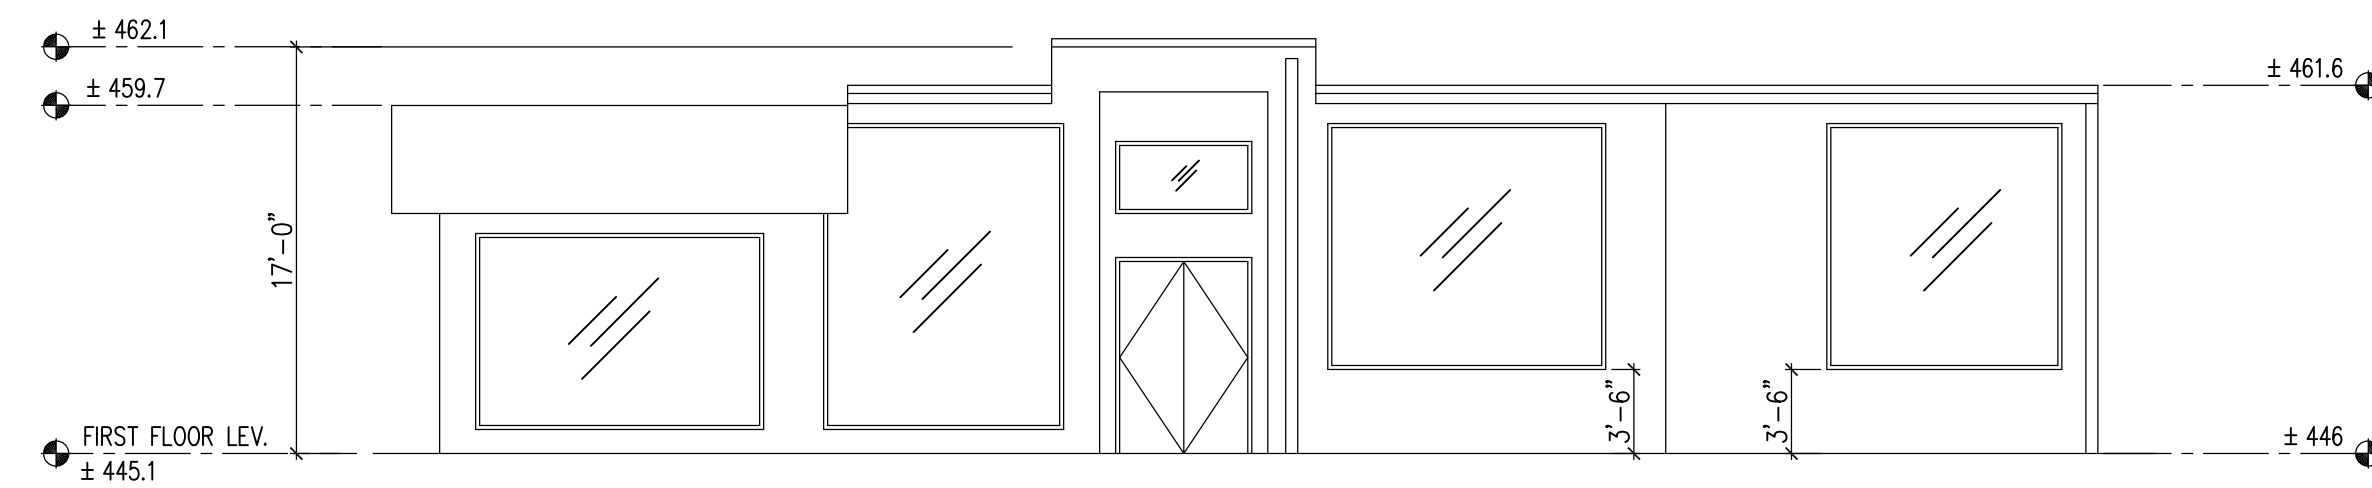
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1/8" = 1'-0"

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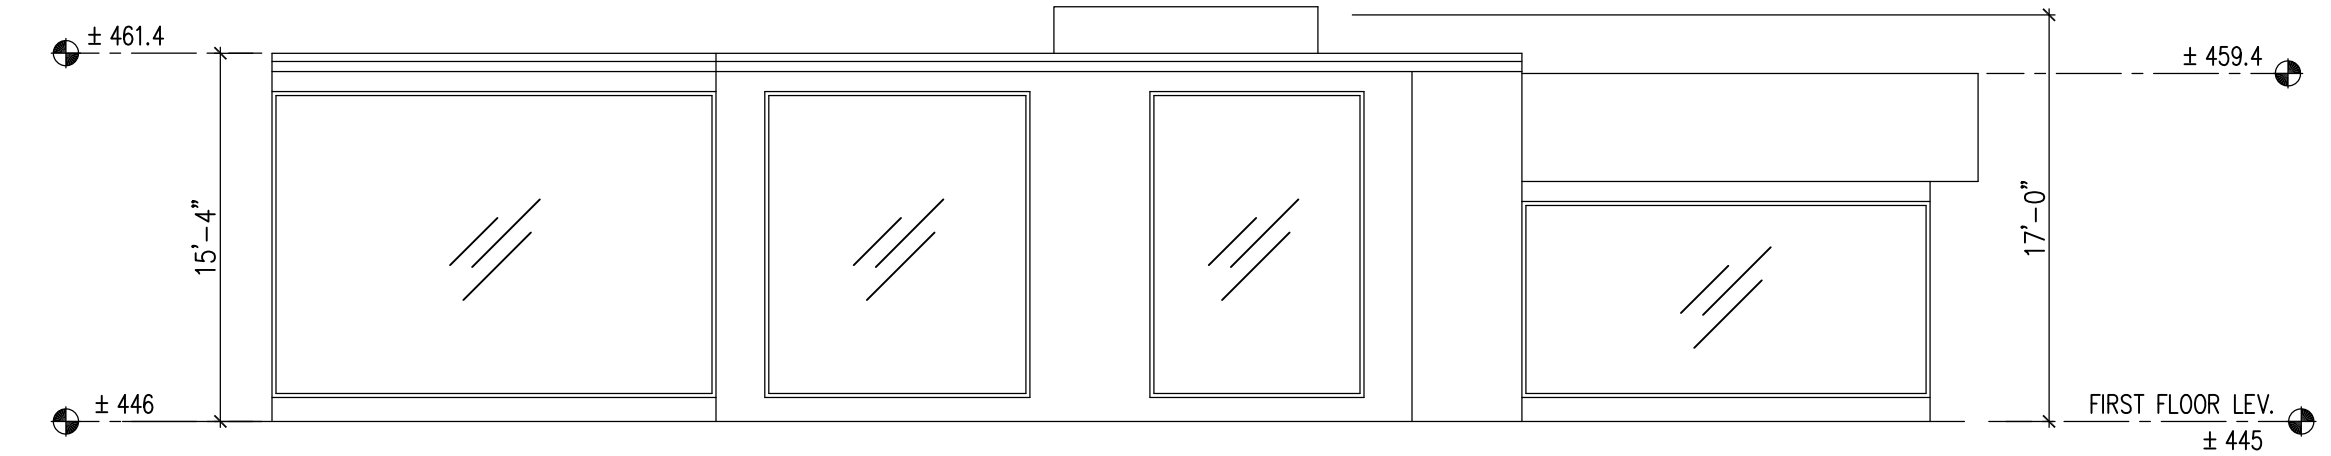
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EAST ELEVATION

SCALE:
1/8" = 1'-0"


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WEST ELEVATION

SCALE:
1/8" = 1'-0"


2



NORTH ELEVATION

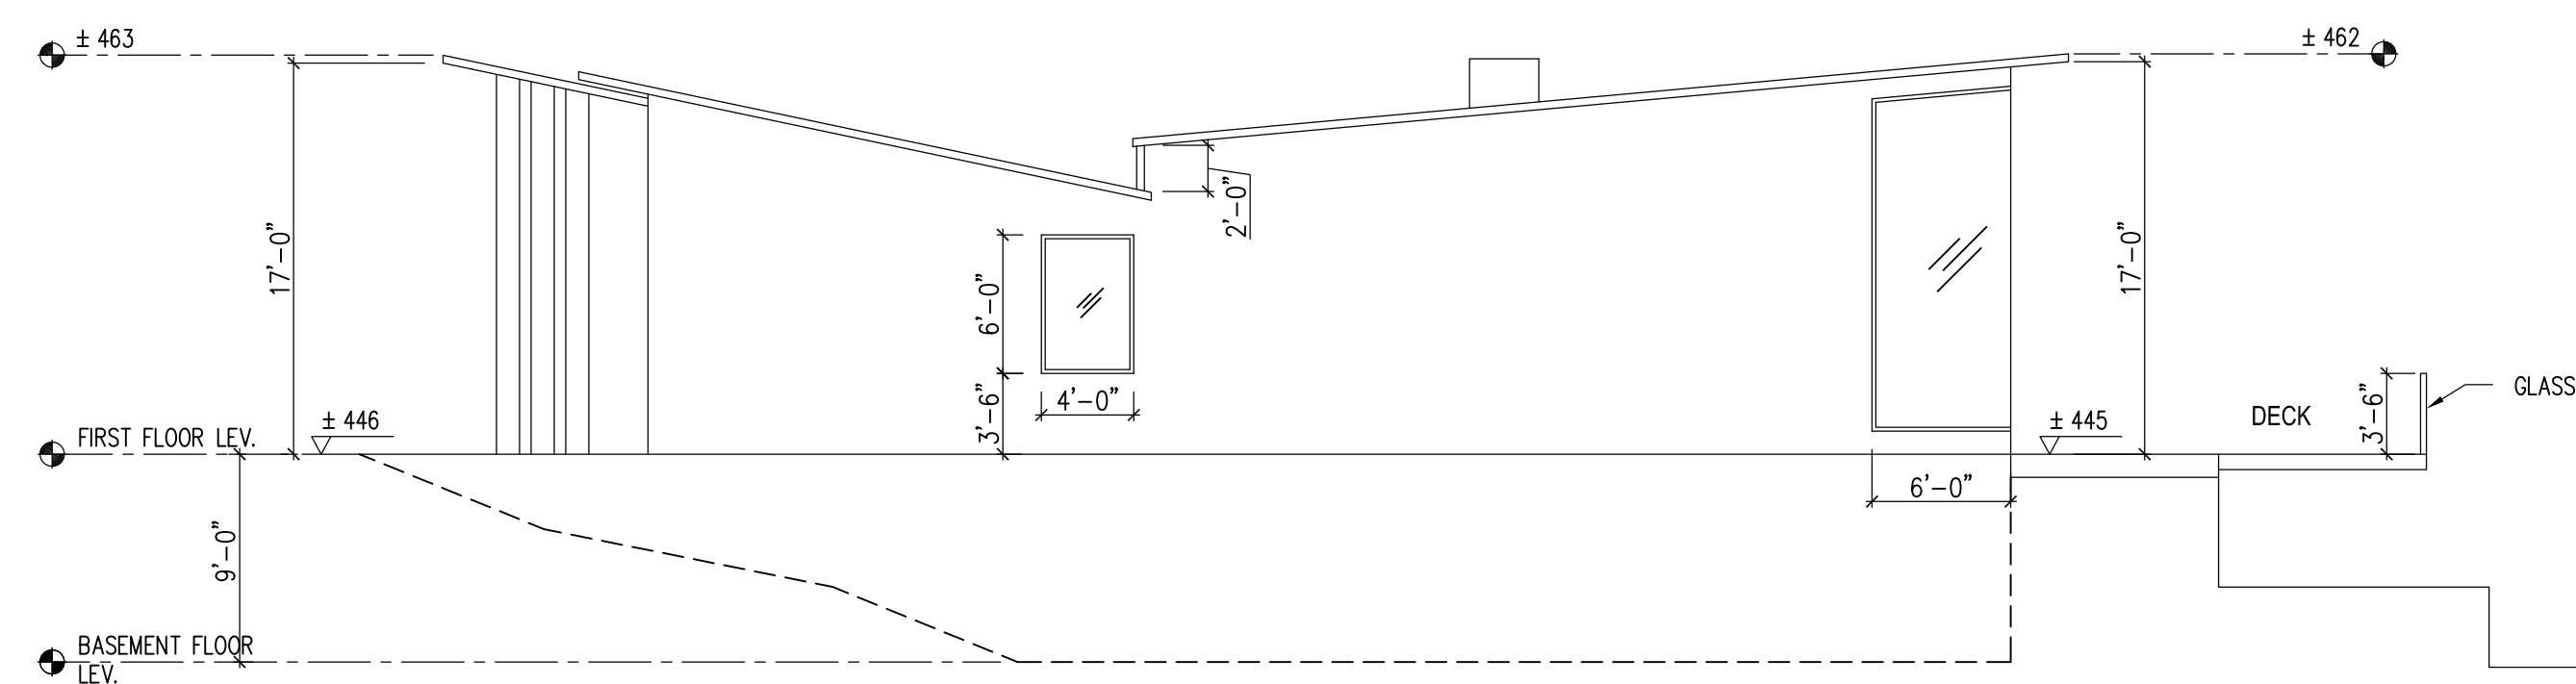SCALE:
1/8" = 1'-0"

(1)

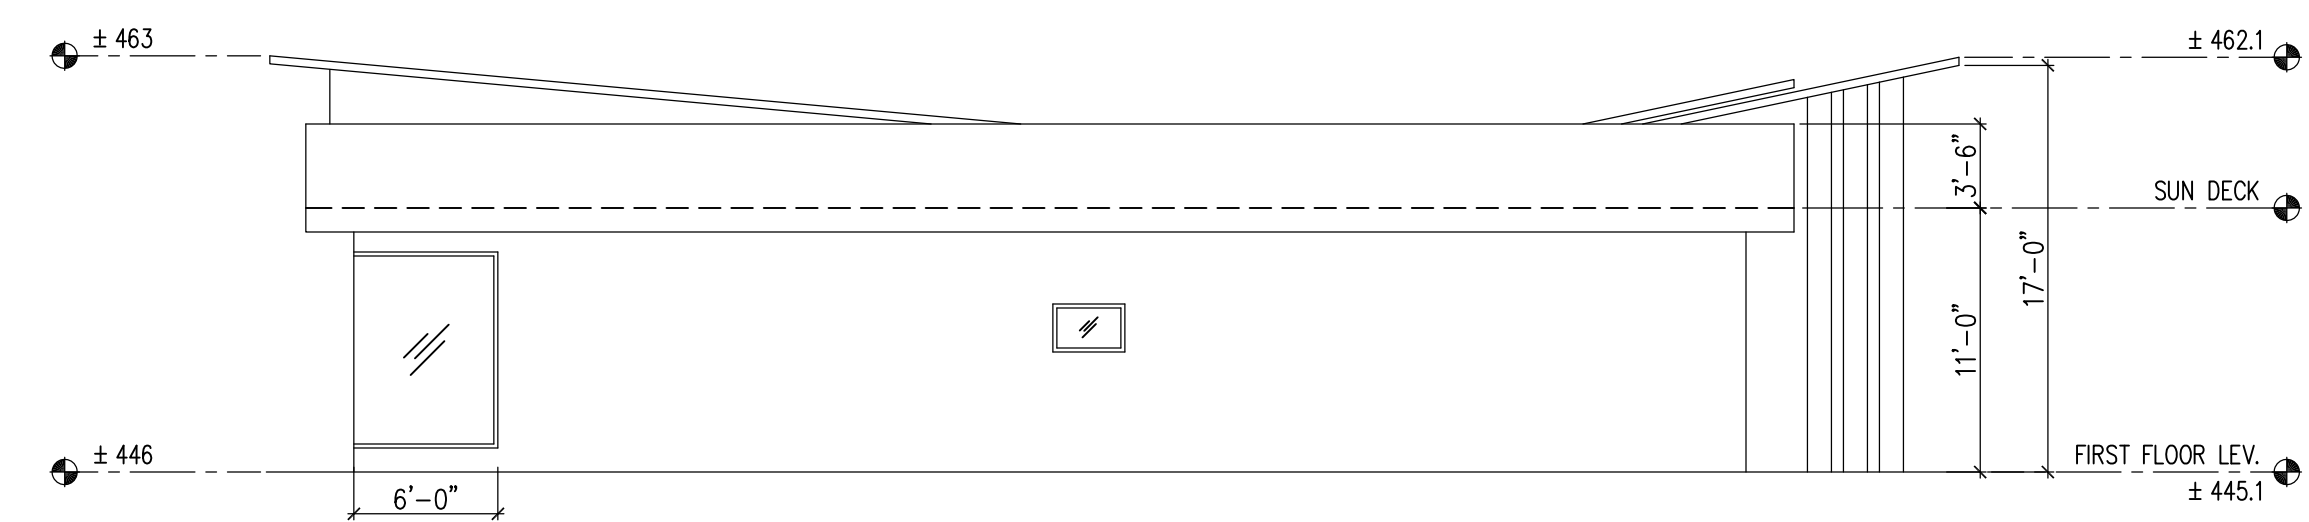

SOUTH ELEVATION

SCALE:
1/8" = 1'-0"

4

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MR. ELLIOT TISHBI
1111 LAS LOMAS AVENUE, PACIFIC PALISADES CA 90272

CT NUMBER
-
JULY 16, 2015

[illegible]

SHEET TITLE
BUILDING
ELEVATIONS

SHEET NO.

A3.2

BOB BADTAIN
AND ASSOCIATE, DESIGN GROUP
1318 16TH ST. SANTA MONICA CA 90404
T 310 . 980 . 1857 F 310 . 393 . 7175



2011 Los Angeles Green Building Code

FORM GRN 14

GREEN BUILDING CODE PLAN CHECK NOTES
RESIDENTIAL BUILDINGS UP TO SIX STORIES

1. For new dwellings and townhouses, provide one 208/240 V 40amp, grounded AC outlets or panel capacity and conduit for the future installation of a 208/240V 40amp, grounded AC outlet. (4.106.6)
2. New residential buildings with common parking areas), shall provide electrical vehicle charging as follows:
- a. A minimum number of 208/240 V 40 amp, grounded AC outlets equal to 5 percent of the total number of parking spaces. The outlets shall be located within the parking area, or
- b. Panel capacity and conduit for future installation of electrical outlets. The panel capacity and conduit size shall be designed to accommodate the future installation, and allow the simultaneous charging, of a minimum number of 208/240 V 40 amp, grounded AC outlets, that is equal to 5 percent of the total number of parking spaces. The conduit shall terminate within the parking area, or
- c. Additional service capacity, space for future meter, and conduit for future installation of electrical outlets. The service capacity and conduit size shall be designed to accommodate the future installation, and allow the simultaneous charging, of a minimum number of 208/240 V 40 amp, grounded AC outlets, that is equal to 5 percent of the total number of parking spaces. The conduit shall terminate within the parking area.
- The panel service capacity and conduit shall be adequately sized. (4.106.6)
3. Each appliance provided and installed meets ENERGY STAR if an ENERGY STAR designation is applicable for that appliance. (4.210, 9.210)
4. The flow rates for all plumbing fixtures shall comply with the minimum flow rates in Table 4.303.2/ Table 9.403.2. (4.303.1, 9.303.1)
5. When single shower fixtures are served by more than one showerhead, the combined flow rate of all the showerheads shall not exceed the maximum flow rates specified in the 20 percent reduction column contained in Table 4.303.2/ Table 9.303.2 or the shower shall be designed to only allow one showerhead to be in operation at a time. (4.303.2, 9.303.2)
6. Installed automatic irrigation system controllers shall be weather- or soil-based controllers. (4.304.1, 9.304.1)
7. Annular spaces around pipes, electric cables, conduits, or other openings in the building's envelope at exterior walls shall be protected against the passage of rodents by closing such openings with cement mortar, concrete masonry, or metal plates. (4.406.1, 9.406.1)
8. Materials delivered to the construction site shall be protected from rain or other sources of moisture. (4.407.4, 9.407.4)
9. Only a City of Los Angeles certified hauler will be used for hauling of construction waste. (4.408, 9.408)
10. For all new equipment, an Operation and Maintenance Manual including, at a minimum, the items listed in Section 4.410.1, shall be completed and placed in the building at the time of final inspection. (4.410, 9.410)
11. All duct and other related air distribution component openings shall be covered with tape, plastic, or sheetmetal until the final startup of the heating and cooling equipment. (4.504.1, 9.504.1)
12. Architectural paints and coatings, adhesives, caulks and sealants shall comply with the Volatile Organic Compound (VOC) limits. (4.504.1-4.504.4, 9.504.1-9.504.4)
13. The VOC Content Verification Checklist, Form GRN 2, shall be completed and verified prior to final inspection approval. The manufacturer's specifications showing VOC content for all applicable products shall be readily available at the job site and be provided to the field inspector for verification. (4.504.5, 9.504.5)
14. All new carpet installed in the building interior shall meet the testing and product requirements of one of the following:
- a. Carpet and Rug Institute's Green Label Plus Program
- b. California Department of Public Health Standard Practice for the testing of VOCs (Specification 01350)
- c. NSF/ANSI 140 at the Gold level
- d. Scientific Certifications Systems Indoor Advantage™ Gold (4.504.3, 9.504.3)
15. All new carpet cushion installed in the building interior shall meet the requirements of the Carpet and Rug Institute Green Label program. (4.504.3.1, 9.504.3.1)
16. 50% of the total area receiving new resilient flooring shall comply with the VOC limits or be certified under the Resilient Floor Covering Institute (RFCI) FloorScore program. (4.504.4, 9.504.4)
17. New hardwood, plywood, particle board, and medium density fiberboard composite wood products used in the interior or exterior of the building shall meet the formaldehyde limits listed in Table 4.504.5/ Table 9.504.5. (4.504.5, 9.504.5)
18. The Formaldehyde Emissions Verification Checklist, Form GRN 3, shall be completed prior to final inspection approval. The manufacturer's specifications showing formaldehyde content for all applicable wood products shall be readily available at the job site and be provided to the field inspector for verification. (4.504.5.1, 9.504.5.1)
19. Building materials with visible signs of water damage shall not be installed. Wall and floor framing shall not be enclosed until it is inspected and found to be satisfactory by the building inspector. (4.505.3, 9.505.3)
20. Newly installed bathroom exhaust fans shall be ENERGY STAR compliant and be ducted to terminate to the outside of the building. Provide the manufacturer's cut sheet for verification. (4.506.1, 9.506.1)
21. Newly installed bathroom exhaust fans, not functioning as a component of a whole house ventilation system, must be controlled by a humidistat which shall be readily accessible. (4.506.1, 9.506.1)
22. New whole house exhaust fans shall have covers or louvers which close when the fan is off and that are insulated with a minimum insulation value of R-4.2. (4.507.1, 9.507.1)
23. The size and layout of the heating and air-conditioning systems shall be in accordance with ACCA Manual J, ACCA 29-D and ACCA 36-S, ASHRAE handbooks. (4.507.2, 9.507.2)

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VOC AND FORMALDEHYDE LIMITS
(2011 Los Angeles Green Building Code)

FORM GRN 11

The tables below are taken from the
2011 Los Angeles Green Building Code
Tables 4.504.1, 4.504.2, 4.504.3, 4.504.4, 4.504.5, 9.504.1, 9.504.2, 9.504.3, 9.504.95, 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